MINUTES OF A MEETING OF THE PLANNING AND DEVELOPMENT COMMITTEE HELD ON TUESDAY 8th OCTOBER 2024 AT 6.45PM AT THE TOWN HALL, MARKET SQUARE, HIGHAM FERRERS

PRESENT:

Cllr G Salmon (Chairman)

Cllr B Spencer

Cllr Mrs P H Whiting

Cllr Mrs A Gardner

Cllr G Kelly

Cllr N Brown

Ms A Schofield (Town Clerk)

1 member of the public

1. **APOLOGIES**

Cllr V Paul.

2. **DECLARATIONS OF INTEREST**

None.

3. MINUTES

RESOLVED:

That the minutes of the meeting held on 10th September 2024 be signed by the Chairman as being a true and correct record.

4. **PUBLIC FORUM**

None.

5. **PLANNING**

- 5.1. To consider response to the following planning applications:-
- (i) NE/24/00791/FUL: Full Planning Permission Detached annexe at 107 Wharf Road, Higham Ferrers

RESOLVED:

That the council has no comments and no objections.

(ii) NE/24/00925/TCA: Tree Work in Conservation Area - T1; Silver Birch – reduce by up to 3 metres in height. T2; Sycamore – re-pollard to previous points by reducing the crown by approx 3 metres, at 18 College Street Higham Ferrers

RESOLVED:

That the council has no comments and no objections.

5.2. To receive and note the town council's application for tree works at Castle Fields. **RESOLVED:**

That the town council's application for tree works at Castle Fields be received and noted.

5.3. To receive and note determinations on planning applications. RESOLVED:

That the following determinations on planning applications be received and noted:-

APPROVAL

NE/24/00632/FUL – 9 Tenter Close, Higham Ferrers, NN10 8AF Single storey side extension.

NE/24/00796/FUL - 8 Williams Way, Higham Ferrers, NN10 8AJ Single storey rear extension.

NE/24/00828/FUL – 5 Mallard Close, Higham Ferrers, NN10 8JQ First floor side extension.

6. **ITEMS TO REPORT**

None.

7. **DATE OF NEXT MEETING**

12th November 2024

Chairman

Date

PLANNING & DEVELOPMENT COMMITTEE 12TH NOVEMBER 2024

PLANNING APPLICATIONS SUMMARY

NE/24/00995/FUL: Full Planning Permission – Replacement storage outbuilding, first floor extension, external alterations, roof alterations at 104 Wharf Road, Higham Ferrers Applicant: Mr M Page

Proposed works described as new external storage applied to the side of the site with a new built up dormer design to the front elevation, with alterations made to the roof profile.

External materials proposed to match the existing.

Applicants have not stated that the 'storage' building is to be used for parking vehicles and have stated that existing parking spaces will be retained on the driveway.

Comment from Highways:

NNC (Transport & Highways)

In respect of the above planning application, the local highway authority (LHA) has the following observations, comments and recommendations:

The local highway authority (LHA) cannot support this application in its current form and therefore, require more information on the following points;

o The applicant is required to provide the correctly dimensioned garages/carports; garages will need to have an internal measurement of 3.3 metres x 6 metres, in line with the detail contained within the NNC Adopted Parking Standards. Where a garage is intended to serve two vehicles the internal dimensions for the width need to be increased to 5.8 metres.


o The gradient of the access must not exceed 1:15 for the first 5 metres into the site from the back of the highway boundary; the back of the footpath in this instance.

o A means of drainage across the back of the highway boundary (linear drain), across the proposed site access draining to soakaways contained within the applicant's own land is required. It is unlawful for surface water to drain from private property onto the public highway.

NE/24/01080/FUL: Full Planning Permission – Install air source heat pump (retrospective) at 56 Larkin Gardens, Higham Ferrers

Applicant: N Behagg

Application is retrospective, work is stated to have taken place from 2nd-6th September 2024. No impact on existing parking arrangements.

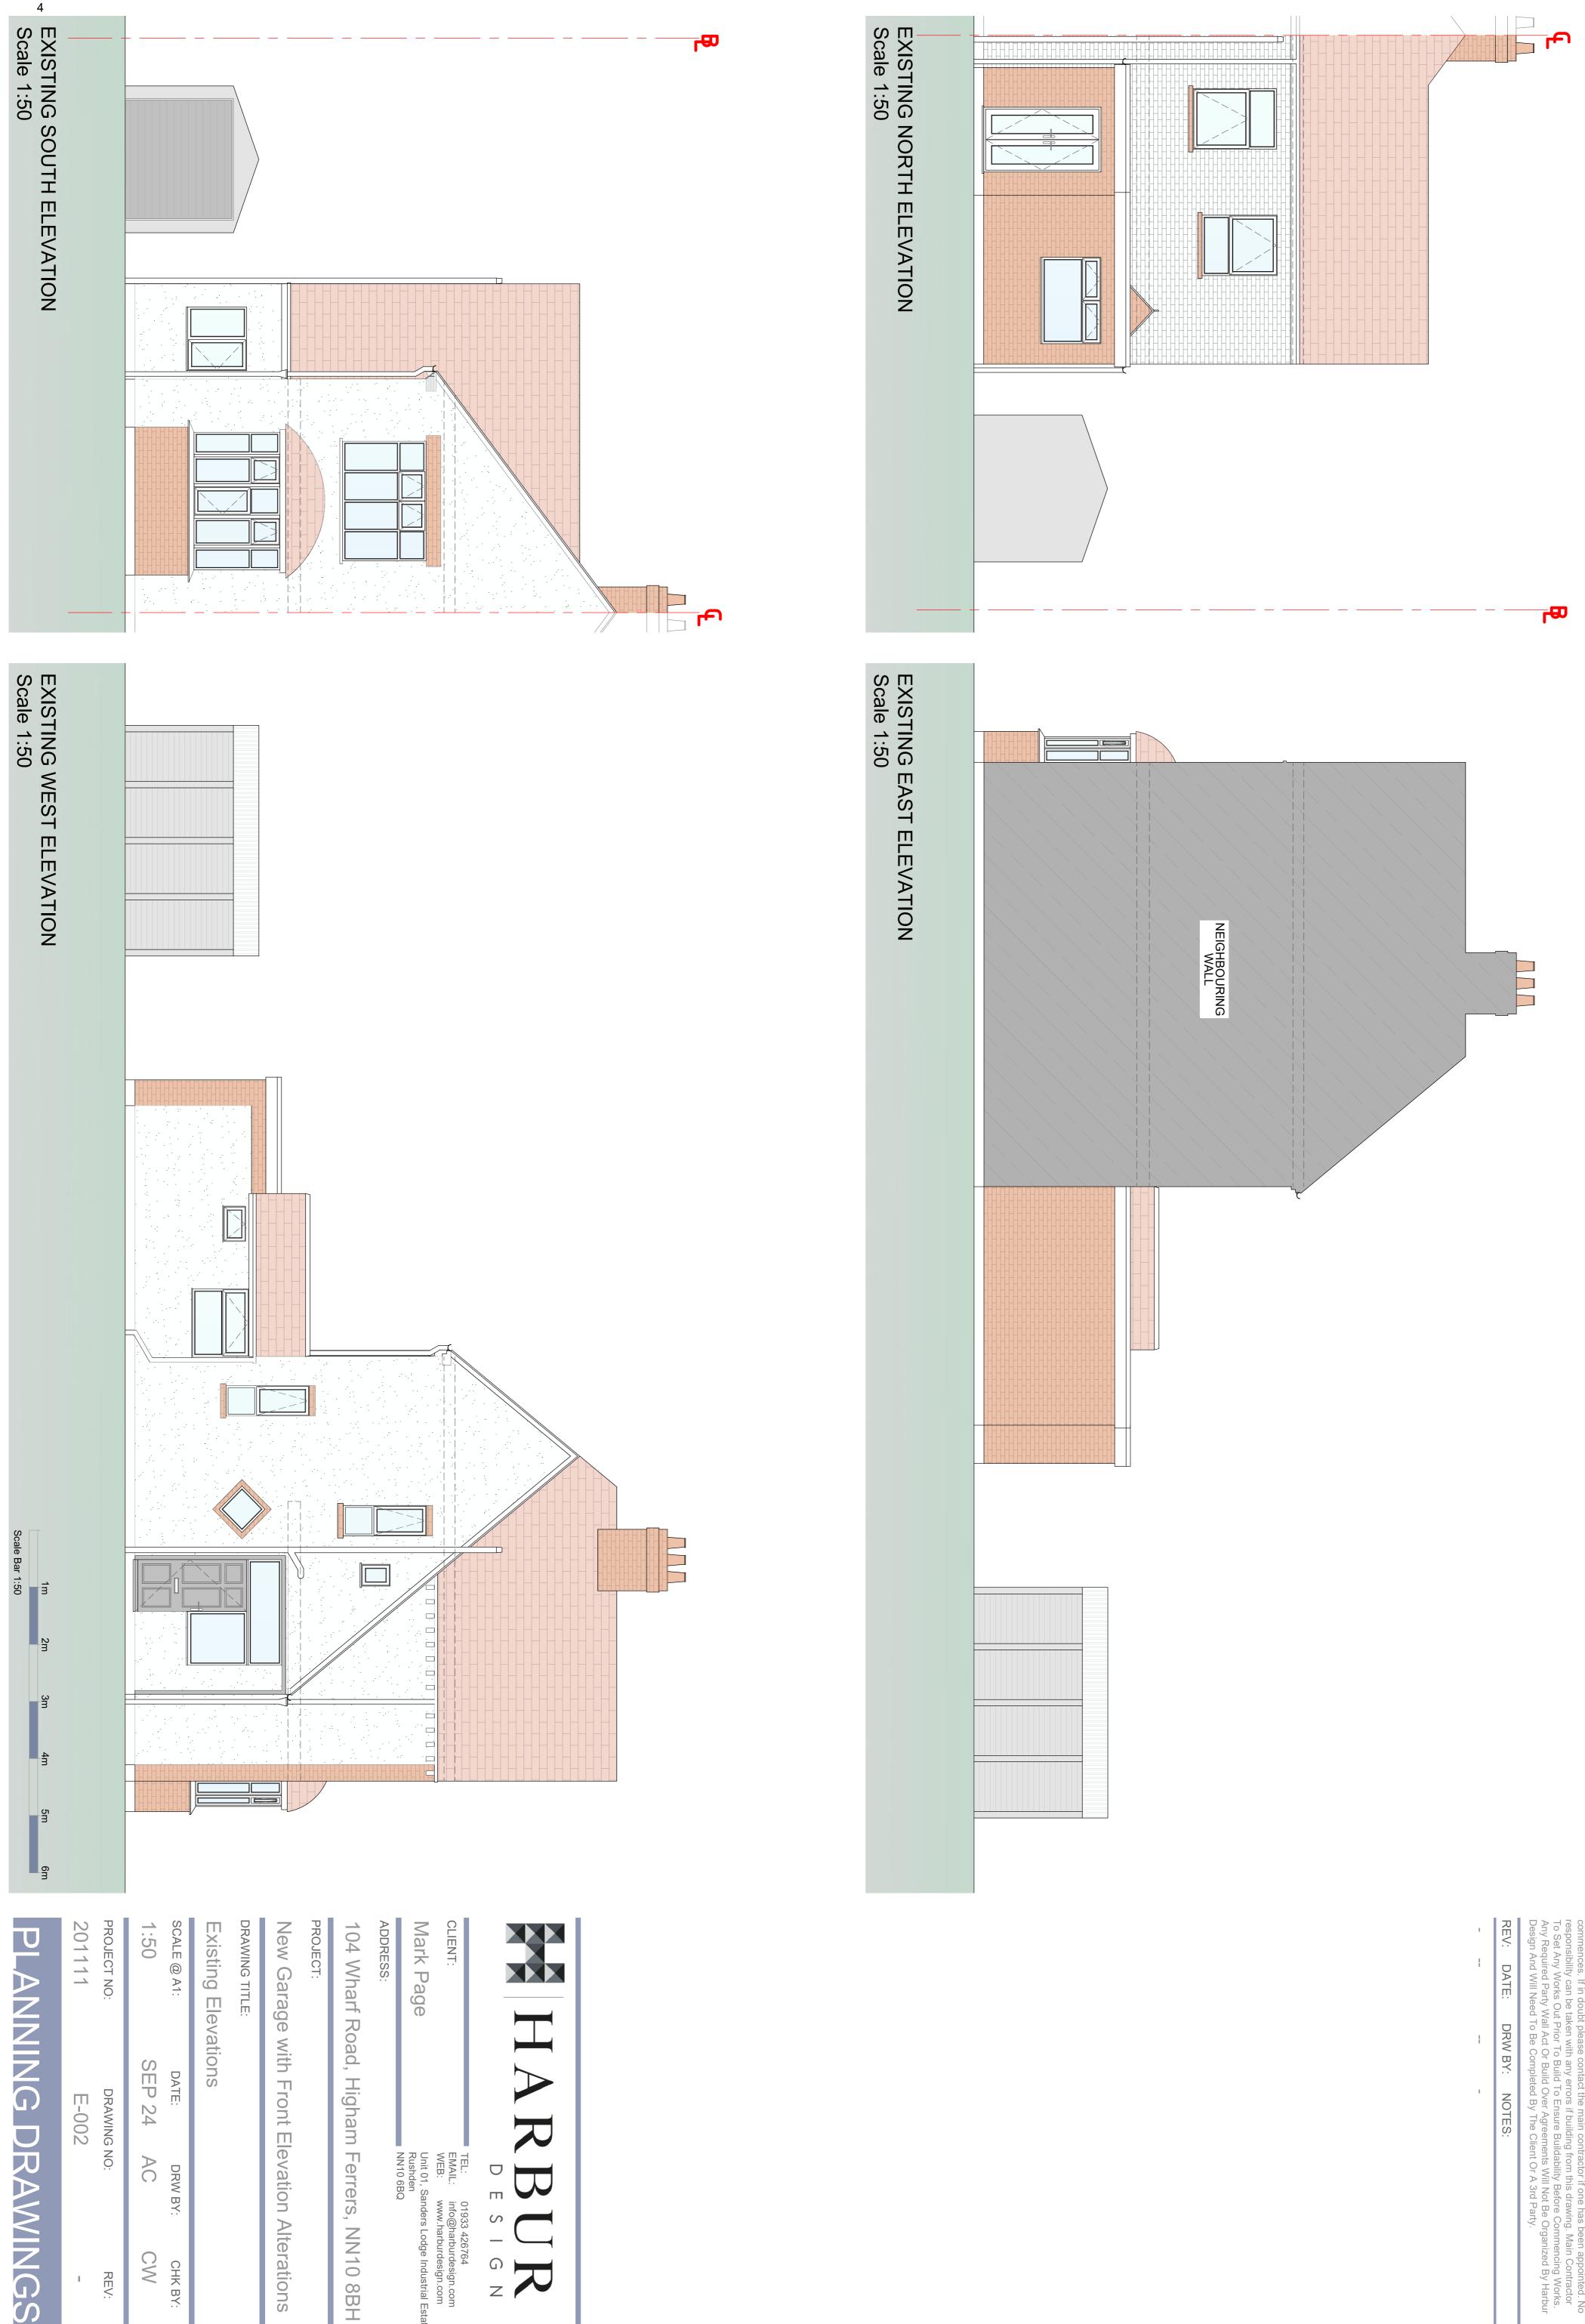

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SEP 24

AC

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DRAWING NO:

REV:

E-002

DATE:

DRW BY:

СНК ВҮ:

TEL: 01933 426764
EMAIL: info@harburdesign.com
WEB: www.harburdesign.com
Unit 01, Sanders Lodge Industrial Estate
Rushden
NN10 6BQ


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DISCLAIMER:

All drawings are provided for planning purposes only. Drawings have been created from a non-intrusive survey and all dimensions must be checked on site before any work commences. If in doubt please contact the main contractor if one has been appointed. No responsibility can be taken with any errors if building from this drawing. Main Contractor To Set Any Works Out Prior To Build To Ensure Buildability Before Commencing Works. Any Required Party Wall Act Or Build Over Agreements Will Not Be Organized By Harbur Design And Will Need To Be Completed By The Client Or A 3rd Party.

DRW BY:

NOTES:

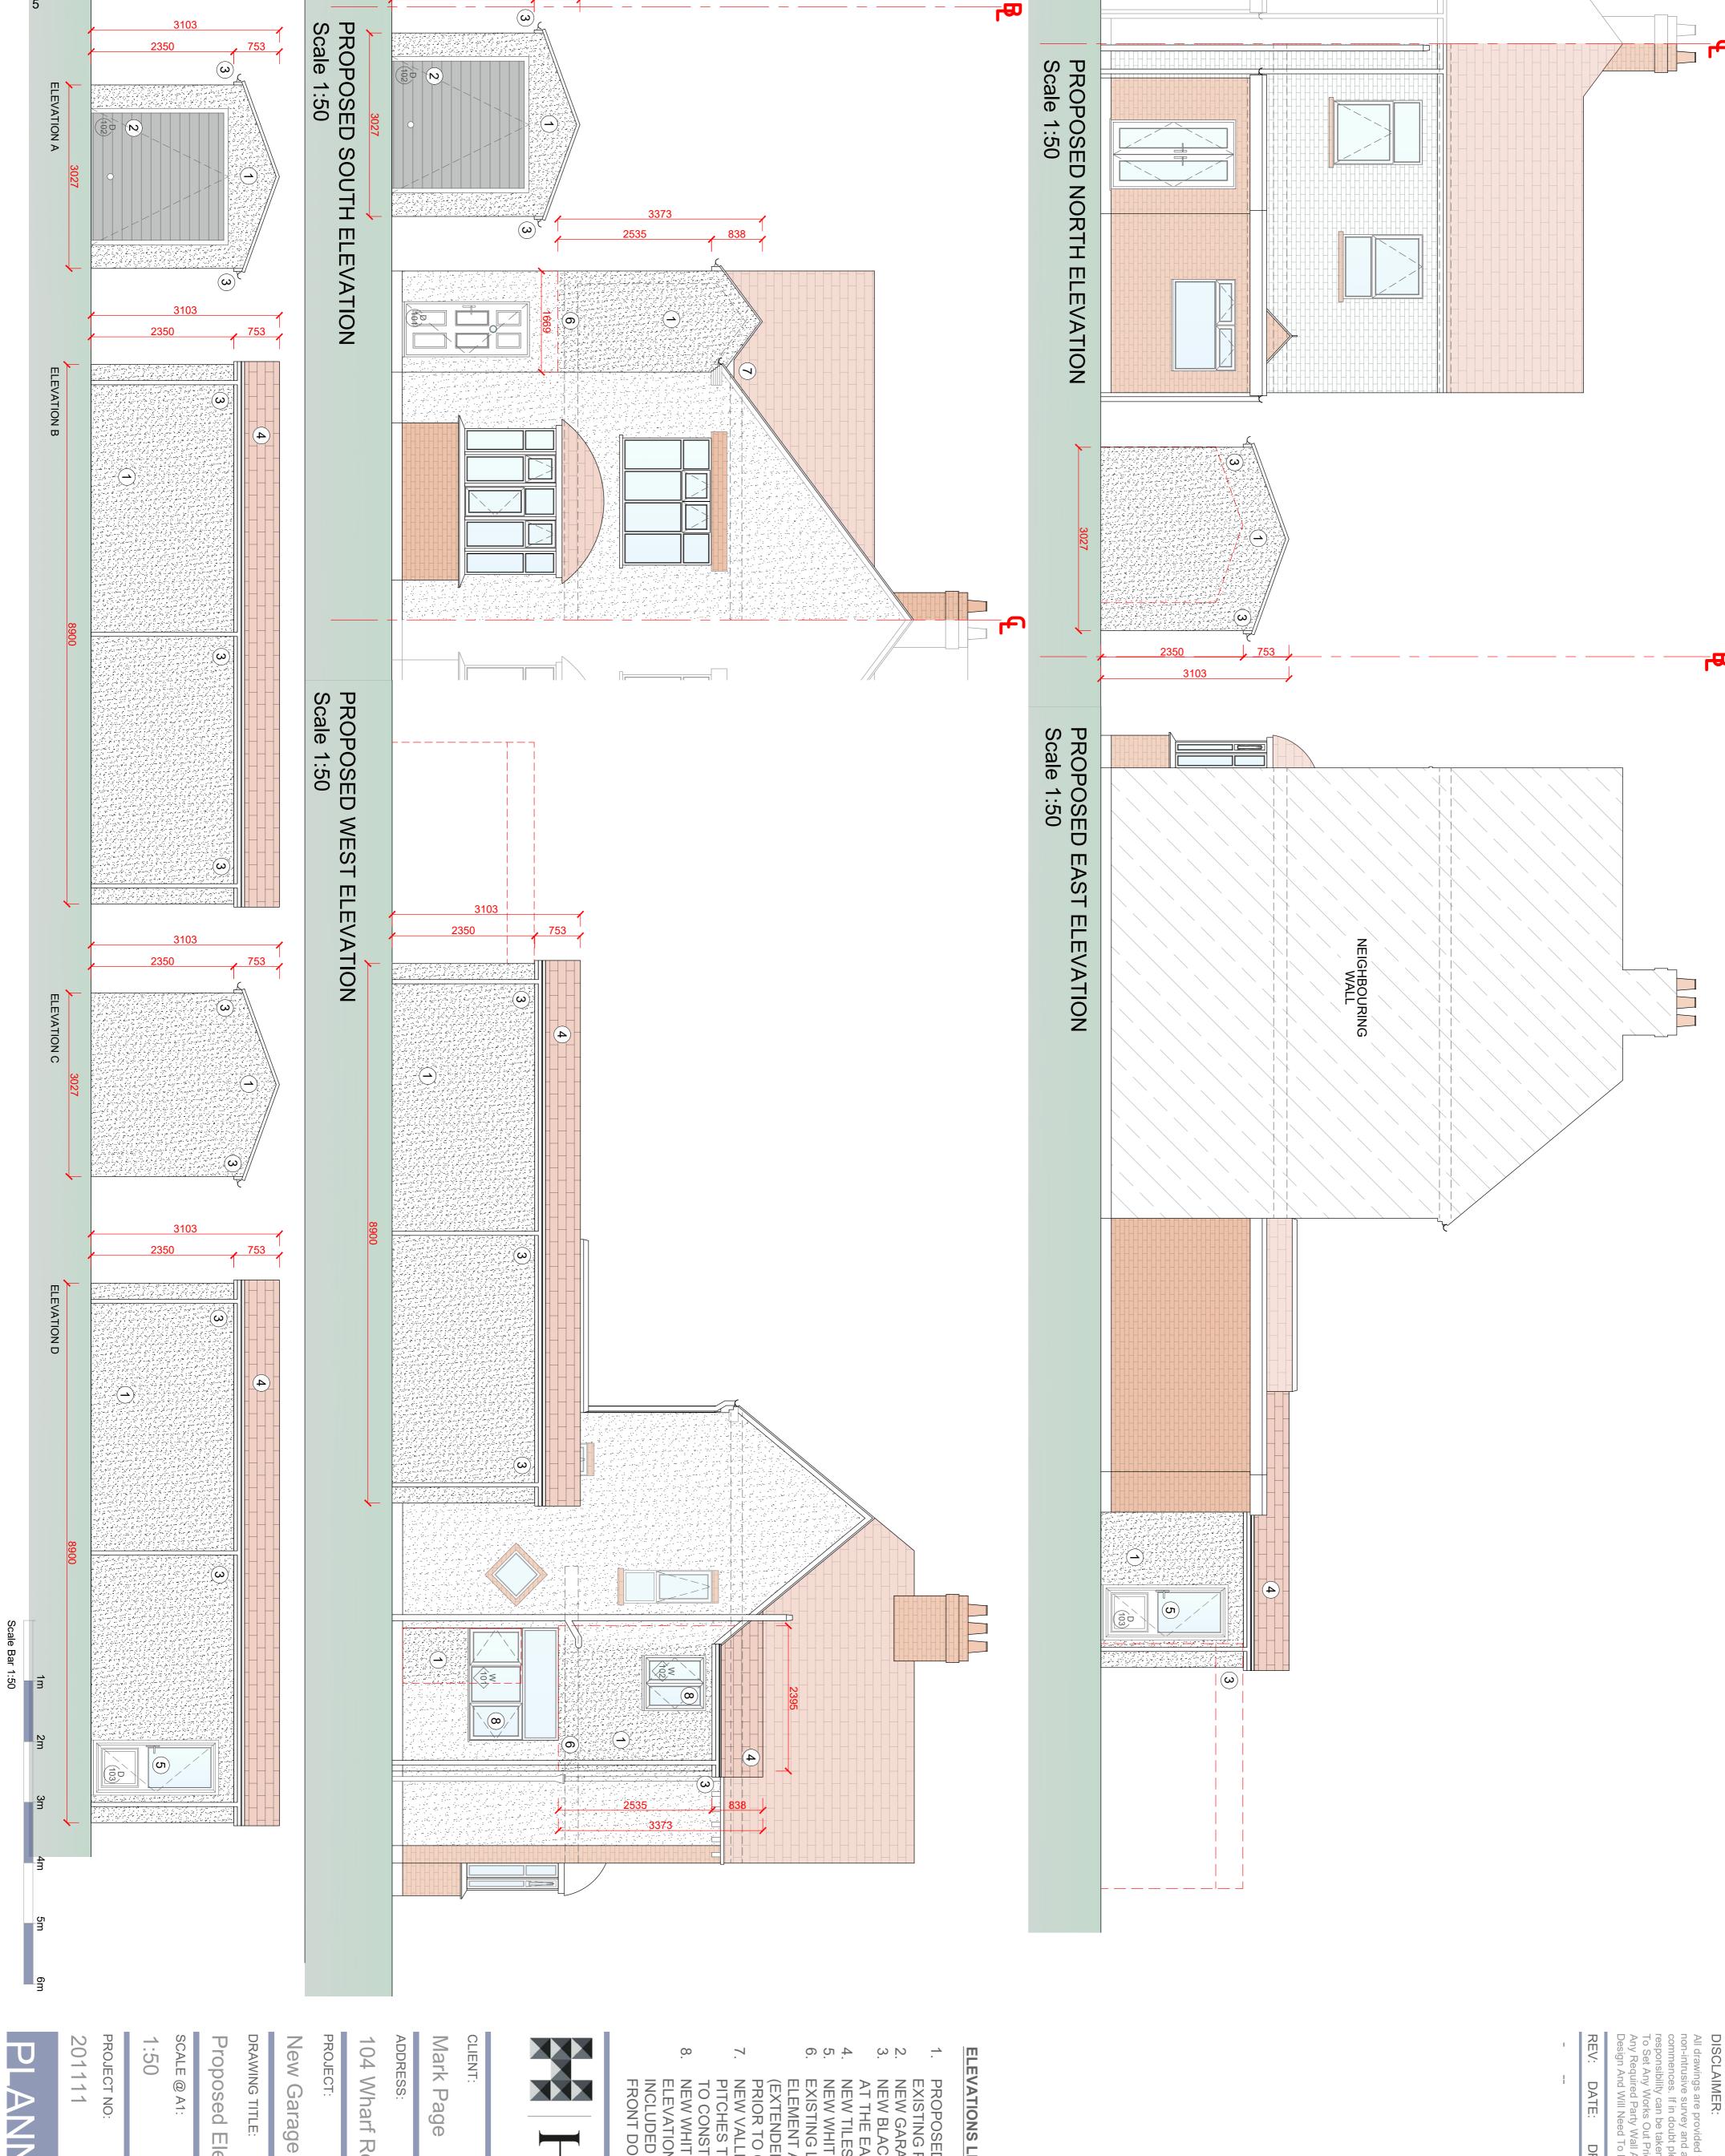

To Ensure Buildability Before Co Over Agreements Will Not Be O ed By The Client Or A 3rd Party

DRW BY: NOTES:

ELEVATIONS LEGEND

- EXISTING PROPERTY

 NEW GARAGE DOOR IN ANTHRACITE

 NEW BLACK WATER GOODS AND FACADE BOARDS
 AT THE EAVES

 NEW TILES TO CLOSELY MATCH EXISTING
 NEW WHITE UPVC SIDE ACCESS DOOR
 EXISTING LINE DENOTES THE SINGLE STOREY
 ELEMENT AND WHAT IS BEING PROJECTED
 (EXTENDED) FROM TO BE EVALUATED ON SITE
 PRIOR TO COMMENCEMENT
 NEW VALLEY GUTTERING BETWEEN THE TWO ROOF
 PITCHES TO BE IN LEAD LINING OR EPDM SUBJECT
 TO CONSTRUCTION
 NEW WHITE UPVC WINDOWS APPLIED TO THE SIDE
 ELEVATION GROUND FLOOR WINDOW TO BE
 INCLUDED FOLLOWING REMOVING THE EXISTING
 FRONT DOOR AND HAVING THIS RELOCATED

IEL: 01933 426764 EMAIL: info@harburdesign.com WEB: www.harburdesign.com Unit 01, Sanders Lodge Industrial Estate Rushden NN10 6BQ

104 Wharf Road, Higham Ferrers, NN10

8 В Н

with Front Elevation Alterations

Proposed Elevations

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SCA	SCALE @ A1:	DATE:	DRW BY:	CHK BY:
1:50	50	SEP 24	AC	CW
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PLANNING DRAWINGS



DISCLAIMER:
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11.10.24 DATE: DRW BY: CW NOTES:

AMENDED NAME OF EXISTING STORAGE OUTBUILDING

6

Mark Page TEL: 01933 426764
EMAIL: info@harburdesign.com
WEB: www.harburdesign.com
Unit 01, Sanders Lodge Industrial Estate
Rushden
NN10 6BQ \Box

ADDRESS: 104 Wharf Road, Higham Ferrers, NN10 8BH

PROJECT: New Garage with Front Elevation Alterations

EXISTING GROUND FLOOR PLAN Scale 1:50

EXISTING FIRST FLOOR P Scale 1:50

EXISTING ROOF PLAN Scale 1:50


DRAWING TITLE:

Existing Plans

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PLANNING DRAWINGS



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REV: DATE: DRW PV.

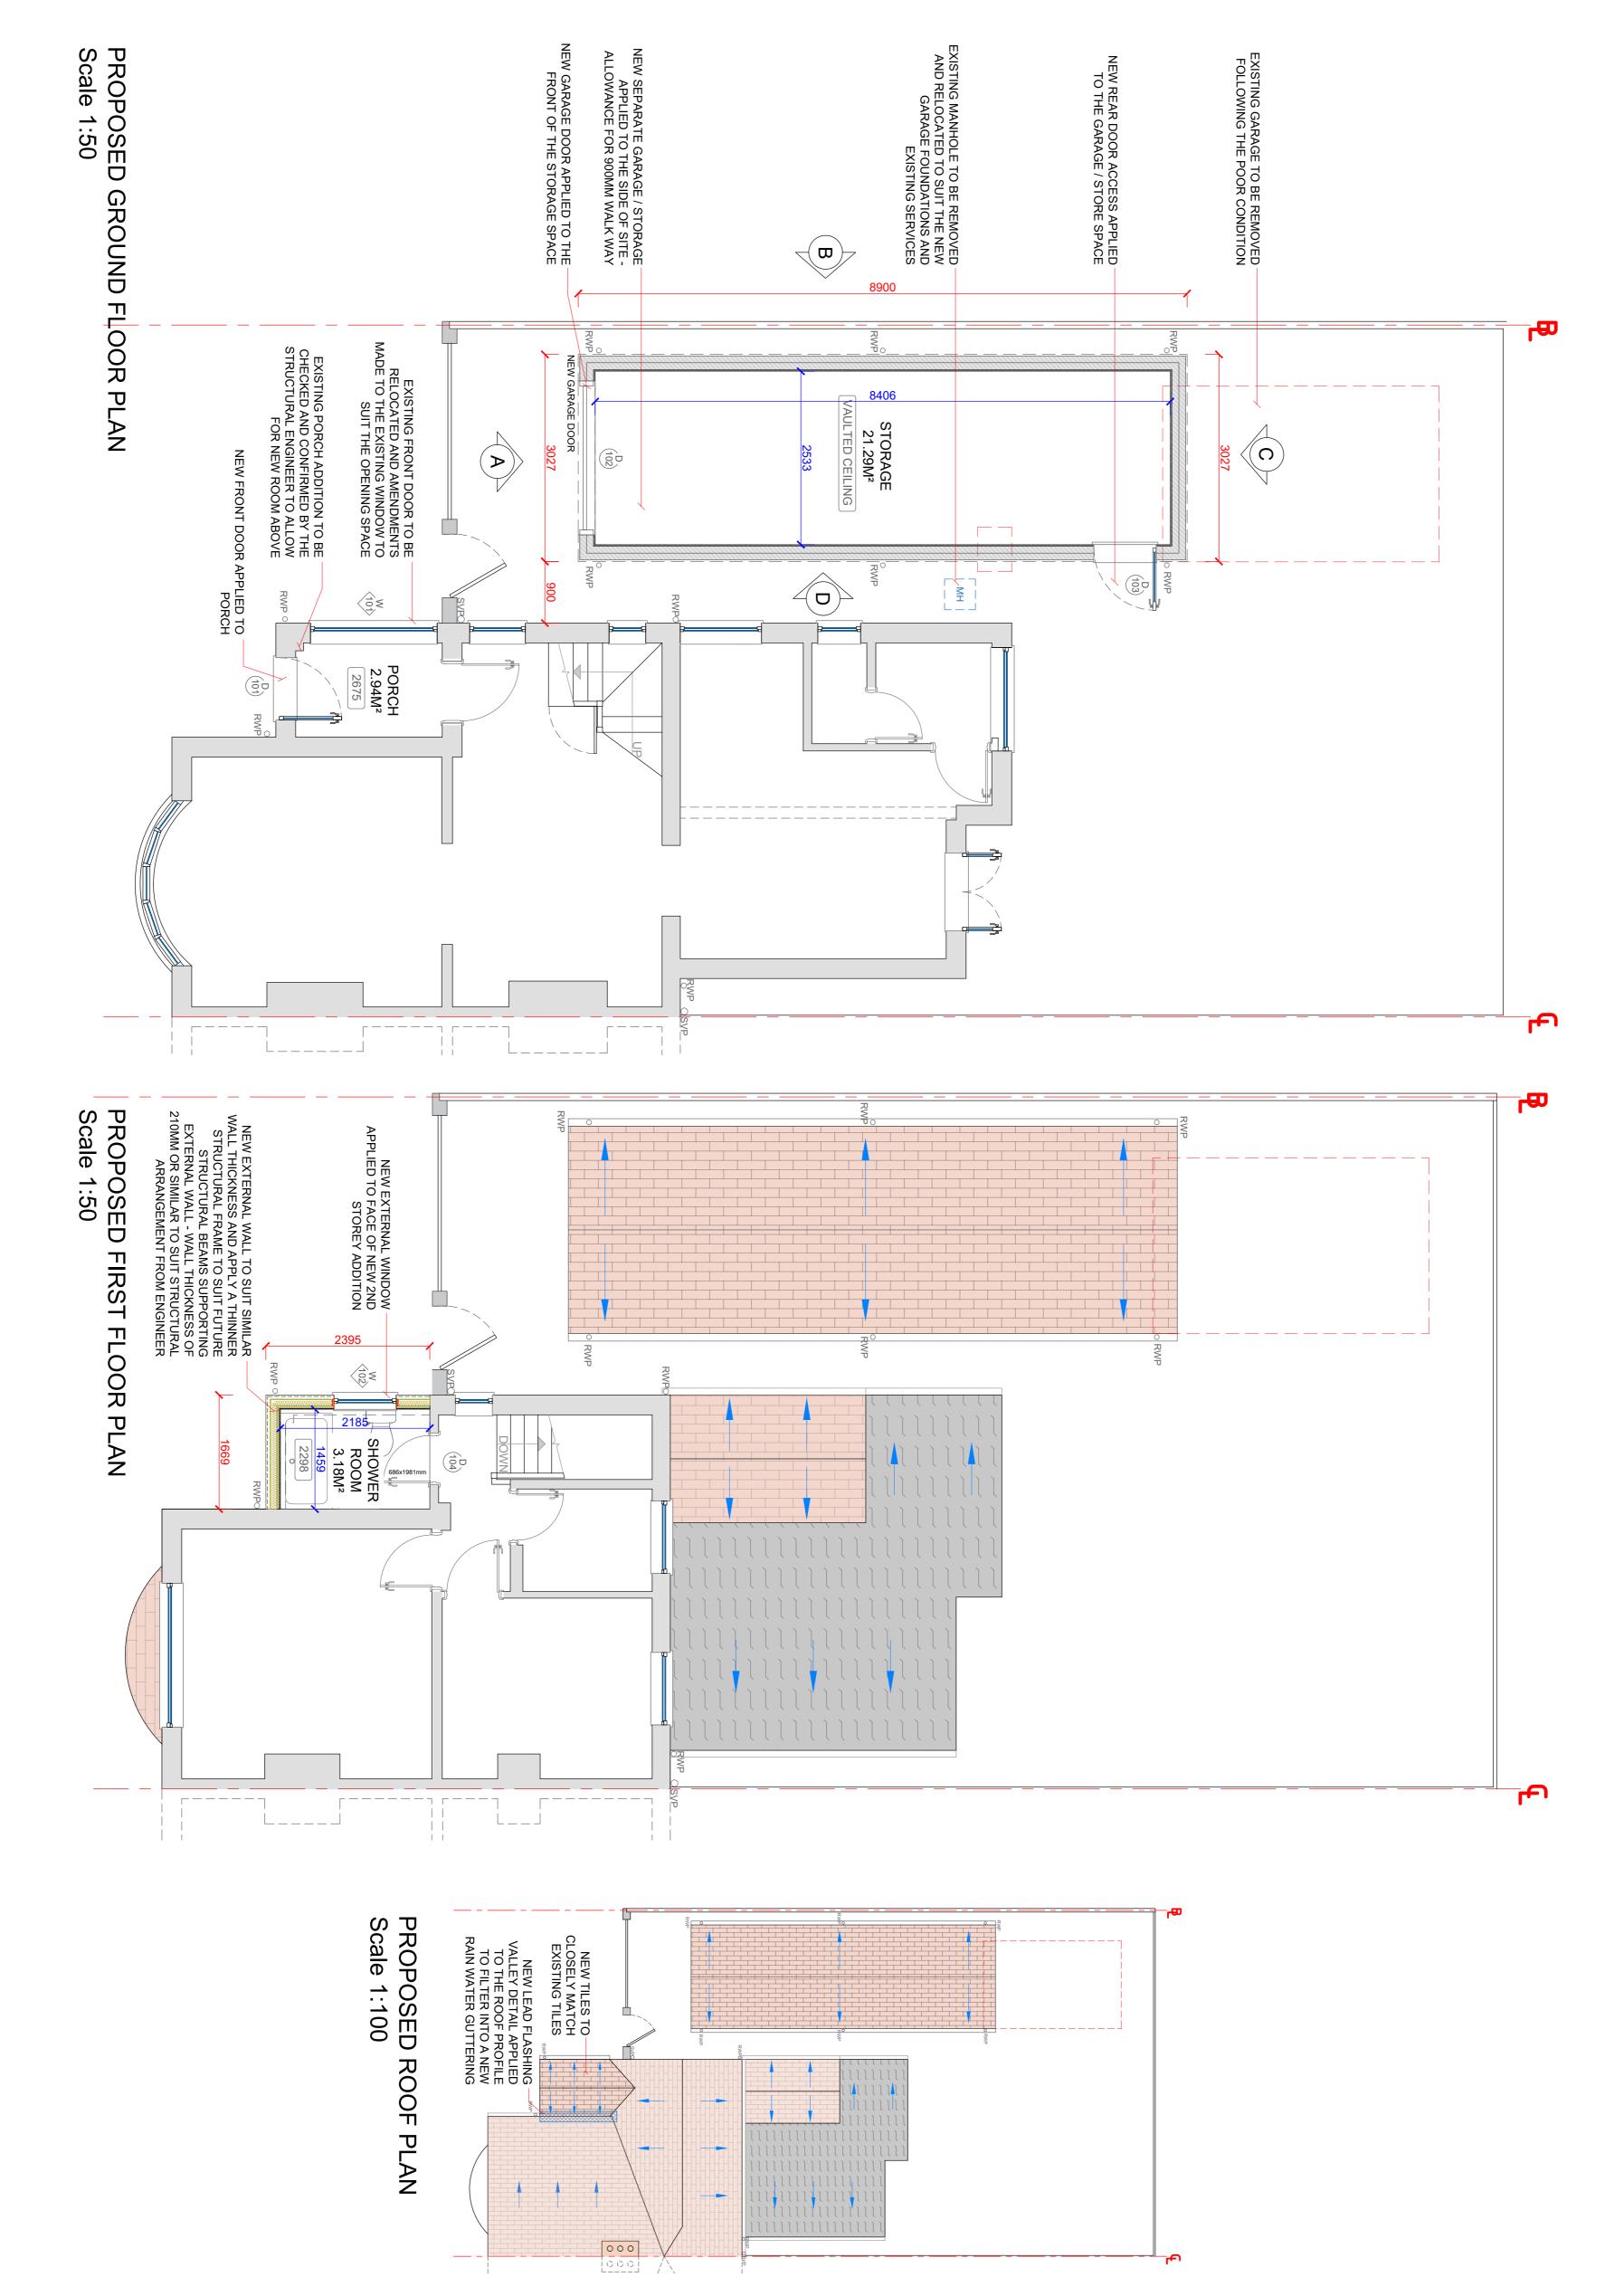DISCLAIMER:

PROJECT NO: SCALE @ A1: 201111 1:50 / 1:100 **SEP 24** DATE: DRAWING NO: P-001 AC DRW BY: $\mathbb{C}\mathbb{W}$ СНК ВҮ: REV:

PLANNING DRAWINGS


Proposed Plans

Scale Bar 1:50

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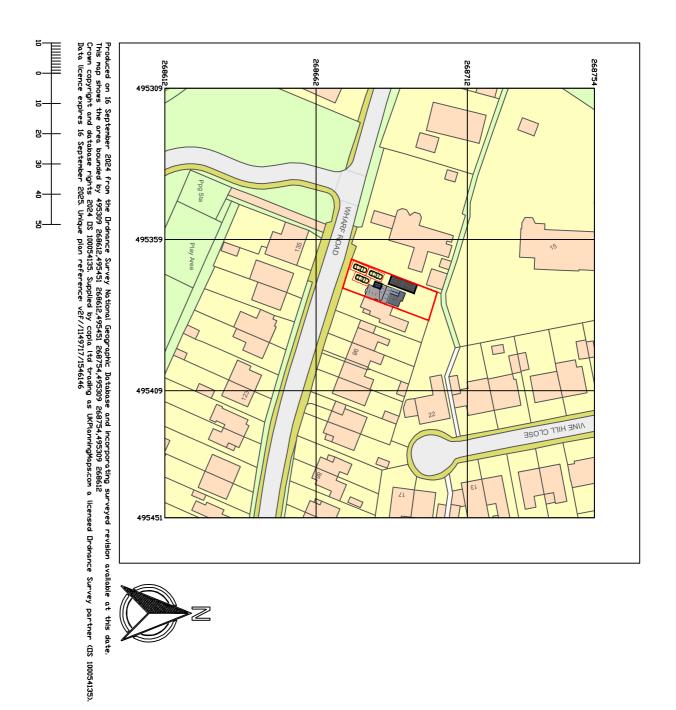
CLIENT: DRAWING TITLE: Mark Page PROJECT: New Garage with Front Elevation Alterations 104 Wharf Road, Higham Ferrers, ADDRESS: TEL: 01933 426764
EMAIL: info@harburdesign.com
WEB: www.harburdesign.com
Unit 01, Sanders Lodge Industrial Estate
Rushden
NN10 6BQ \Box

NN10 8BH

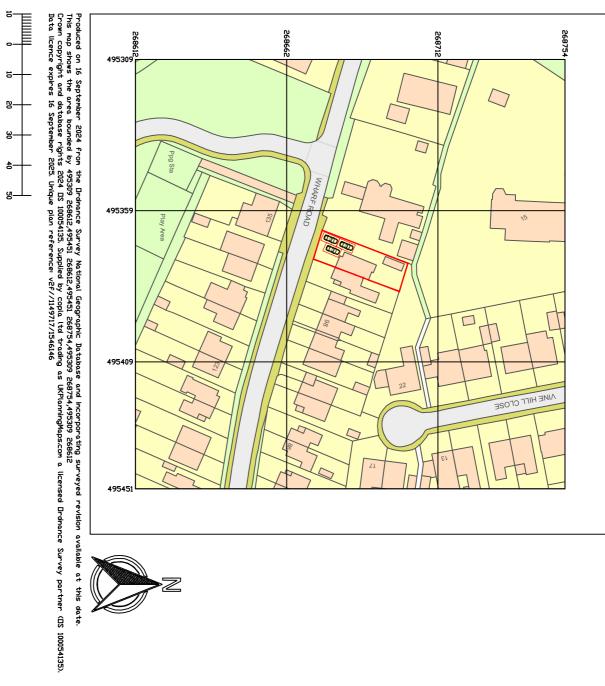

EXISTING SITE LOCATION PLAN Scale 1:1250





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11.10.24

CW

PARKING PARAMETERS INCLUDED AS PER COUNCIL COMMENTS

DATE:

DRW BY:

NOTES:

DISCLAIMER:

PROPOSED SITE LOCATION PLAN Scale 1:1250



8

ADDRESS:	Mark Page	CLIENT:	
	Unit 01, Sanders Lodge Industrial Estate Rushden NN10 6RO	TEL: 01933 426764 EMAIL: info@harburdesign.com WEB: www.harburdesign.com	D E S I G N

104 Wharf Road, Higham Ferrers, NN10 8BH

New Garage with Front Elevation Alterations PROJECT:

DRAWING TITLE: Existing & Proposed Site Location & Block Plan

		ı		
201111	PROJECT NO:	1:500/1:1250	SCALE @ A1:	
SL-001	DRAWING NO:	SEP 24	DATE:	
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PLANNING DRAWINGS





© Octopus Energy 2024

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Scale: 1:1250 @A3

Date Produced: 04-Nov-2024





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Planning Portal Reference: PP-13448834v1

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Product Data Sheet

NOMINAL CAPACITY			
	kW	6	
COEFFICIENT OF PERFORMANCE (A7/W35) @5.63 kW - EN14511	СОР	4.29	
COEFFICIENT OF PERFORMANCE (A7/W65) @5.23 kw - EN14511	СОР	2.71	
Length	Mm	855	
Height	Mm	1124	
Depth	Mm	595	
Weight	Kg	100	
Connection		G1 Flat face Union	
Sound power level (A7W35)	Db	53.8	
Maximum flow temperature	(°c)	75	
Maximum operating pressure	Bar	32	
Maximum volume flow	L/h	20	
Minimum volume flow	L/h	7	
Minimum system volume	L	100	
Refrigerant type		R290	
Refrigerant charge weight	Kg	0.650	
Electrical supply		230v/1ph/50hz	
Maximum current	А	16	
Starting technology		Inverter	
Compressor type		Scroll	
Compressor Oil type		HATCOL 4467	
Pipe connections		G1 flat face union	
Rated voltage	V	230	
Rated max current	d max current A 16		
Fuse type	Α	Type B	
Rcd type		С	
Maximum cable length (Modbus)	М	30	
Ip rating		IPX5	
FAN MAXIMUM INPUT POWER	w	85	
FAN MAX ROTOR SPEED	Min ⁻¹	760	



r	leil Behagg - 56 Larkin Gardens, Higham Ferrers, NN1	U &PE	Distance	11
			Barrier	Not See
	MCS 020 - Manual Sound Calculator	•	Heat Pump	Cosy6
			Reflecting Surfaces	1
Step	Instructions	MCS contractor results/notes		39.63
1	From manufacturer's data, obtain the A-weighted sound power level of the heat pump. See 'Note 1:Sound power level'. The highest sound power level specified should be used (the power in "low noise mode" should not be used). Example: Manufacturer's data states the sound power	56.3		Pass
2	level of the heat pump is 55 dB(A) Use 'Note 2: Sound pressure level' and 'Note 3: Determination of directivity' below to establish the directivity 'Q' of the heat pump noise. Example: The heat pump is to be installed on the ground and against a single wall hence the directivity (Q) of the heat pump noise is Q4	Q4		
3	Measure the distance from the heat pump to the assessment position in metres Example. Distance between heat pump and assessment position is 4 metres.	11		
4	Use table in 'Note 4: dB distance reduction' below to obtain a dB reduction Example. 4metres@ Q4 = -17 db	-25.6		
5	Establish whether there is a solid barrier between the heat pump and the assessment position using 'Note 5: Barriers between the heat pump and the assessment position' and note any dB reduction. Example. There is a brick wall between the heat pumpand the assessment position Moving less than 25cm enables the assessment position to be seen dB reduction = -5 dB	-10		
6	Calculate the sound pressure level (see 'Note 2: Sound pressure level') from the heat pump at the assessment position using the following calculation: (STEP 1) + (STEP 4) + (STEP 5) Example (55) + (-17) + (-5)=55 -17 - 5 = 33 dB(A) Lp	20.7		
7	Background noise level. For the purposes of the MCS Planning Standard for air source heat pumps 40 dB(A) the background noise level is assumed to be 40 dB(A) Lp. For information see 'Note 6: MCS Planning Standard for air source heat pumps background noise level'. Example. Background noise level is 40 dB(A)	40		
8	Determine the difference between background noise level and the heat pump noise level using the following calculation: (STEP 7) - (STEP 6) Example: 40 db(A) (background) - 33 dB(A) (heat pump) = 7dB(A)	19.3		
9	Using the table in 'Note 7: Decibel correction' obtain an adjustment figure and then add this to whiever is the higher dB figure from STEP 6 and STEP 7. Round to nearest whole number Example: Adjustment figure is 0.8 dB and higher figure is 40db(A) 40 + 0.8 = 40.8 dB(A) Rounded up to 41 dB(A) Final result at this assessment position is 41db(A)	39.63		
10	Final Result? (Greater or equal to 42 dB(A) is under PD)	Pass		

Higham Ferrers Town Council Ask for: Lisa Greenwood Clerk To The Higham Ferrers Town Telephone: 01832 742143

Council Email:

Town Hall appeals.enc@northnorthants.gov.uk

Market Square Our Ref: NE/24/00028/ADV

Higham Ferrers Your Ref:

Northamptonshire Date: 1 November 2024

NN10 8BT Planning Services:

Dear Sir/Madam

TOWN AND COUNTRY PLANNING ACT 1990

This is a corrected letter – the previous letter sent on 24 October had incorrect information regarding the type of appeal. Please ignore that letter.

Proposal: Signage to advertise the name and nature of the business

(Re-submission of NE/23/00006/ADV)

Location: 28 High Street Higham Ferrers Rushden NN10 8BL.

The above application has previously been the subject of a consultation. I am writing to let you know that an appeal has been made to the Secretary of State against the Council's decision to refuse planning permission.

This appeal will be determined on the basis of written representations. The procedure to be followed is set out in Part 1 of the Town and Country Planning (Appeals) (Written Representations Procedure) (England) Regulations 2009.

As this appeal is proceeding under the Commercial Appeals Service, there is no opportunity for you to submit further comments. We will forward copies of all representations made to us in relation to the application, before it was determined, on to the Planning Inspectorate and the appellant. The Inspector appointed by the Secretary of State will consider these representations when determining the appeal. You have a right to withdraw any representations you made so that they are not taken into consideration by the Inspector. If you wish to do so you should make this request in writing directly to the Planning. Please contact

The Planning Inspectorate (East 1), 3O, Temple Quay House, 2 The Square, Bristol, BS1 6PN, telephone no: 0303 444 5302.

The Planning Inspectorate will publish copies of appeal decisions on the Appeals Casework portal https://acp.planninginspectorate.gov.uk

Please quote the Appeal Reference No. **APP/M2840/Z/24/3350533** and the Application Ref. No. **NE/24/00028/ADV** on all correspondence.

For details of how we treat your data, please see our Privacy Notice at www.northnorthants.gov.uk/privacynotices

Yours faithfully

Notifications of planning decisions received for the Town Council

On 12th November

APPROVAL

NE/24/00770/FUL – 91 Kimbolton Road, Higham Ferrers, NN10 8HL Detached garage